## DEPARTMENT OF SCIENCE AND TECHNOLOGY Philippine Atmospheric, Geophysical and Astronomical Services Administration (PAGASA)

22 November 2021

SUPPLEMENTAL / BID BULLETIN ADDENDUM NO. 2021-053-01

Subject: Supply, Delivery, Installation, Testing and Commissioning of Brand-New Redundant Unit of 90TR IT Cooling Application Maglev Oil Free Centrifugal Chiller with Software for Control and Monitoring of Chillers and PACU / ABC Php 18,116,674.90 / PR No. 2021-08-0563 / Ref. No. IB 2021-053

This Bid Bulletin is being issued to all prospective bidders to clarify, amend and/or modify certain provisions in the Bidding Documents and to answer the written clarificatory questions submitted by prospective bidders, to wit:

## Query from SUPERSERVE CORPORATION

## Question(s) PAGASA BAC Answer(s) Item No. 3 on the Invitation to Bid states that "Bidders The Bidder should have completed at least two (2) should have completed, within Three (3) years from similar contracts and the aggregate contract amount the date of submission and receipt of bids, a contract should be equivalent to at least 50% of the ABC. similar to the project". The largest of these similar contracts must be We would like to note that for the past two years, equivalent to at least half of the percentage of the government and private business were significantly ABC as required above. affected by the Covod-19 pandemic that resulted in the nationwide economic slowdown. This was evidenced by a marked reduction in procurement activities due to lockdowns and travel restrictions. Needless to say, a single similar contract amounting to 50% of the ABC of the subject requirement was hard to come by within that period. Hence, we would like to request that two (2) similar contracts with an aggregate contract amount of at least 50% of the ABC be allowed for the reason cited above.

## Query from COFFEL AIRE INDUSTRIES, INC.

Question(s)	PAGASA BAC Answer(s)				
For us to qualify as Bidder/Contractor on your Single Largest Completed Contract (SLCC), the bidder must have completed the supply & installation of Magnetic Bearing / Magnetic Levitation (MAGLEV) Chiller and NOT just mer Supply and Installation of ORDINARY / STANDARD Air Conditioning System as Similar	procure as long as the Data Center or similar facility is included in its cooling system.				

Tel. No. (02) 8284-08-00

Website: http://bagong.pagasa.dost.gov.ph

<sup>&</sup>quot;tracking the sky...helping the country"

Contract since MagLev Chillers are quite complicated in nature but gives you big savings.	
Our similar Single Largest Completed Contract was titled "One (1) Lot Replacement of Centralized Air Conditioning System at the Bangko Sentral ng Pilipinas (BSP) Davao Regional Office, as per BSP Terms of Reference and Approved Drawings" but the project actual requirement was 200TR Magnetic Bearing / Magnetic Levitation (MAGLEV) Chiller. Kindly advise if this is acceptable as our SLCC.	
Is there an existing Building Management System (BMS)? If so, what's the protocol? Kindly clarify.	There is no existing BMS but a Modbus protocol will be implemented soon.
3. Under Scope of Work, sub-items c &d (Layout and Installation of Chilled Water Piping and Electrical Wires & etc., respectively) are required. Can we have a plan of the existing Chiller Plant and its Electrical Plan for us to layout the new chiller location and tapping point?	Please refer to the attached Annex A (Piping Layout) and Annex B (Data Center and Powerhouse Lighting and Power Layout) of this SBB.
4. To properly assess and prepare our proposal, can we conduct a site inspection? If so, please advise the date, time, contract person and phone number.	Yes, you may conduct a site inspection on Thursday (25 Nov 2021) from 08:00 am to 05:00 pm. Please coordinate with Mr. Christopher Dave N. Sabado at telephone no. (02) 8284-0800 loc. 413.

This shall form an integral part of the Bid Documents.


For guidance and information of all participating bidders.


LANDRICO U. DALIDA JR., Ph.D.


Chairperson


PAGASA-BAC for Goods and Consulting Services


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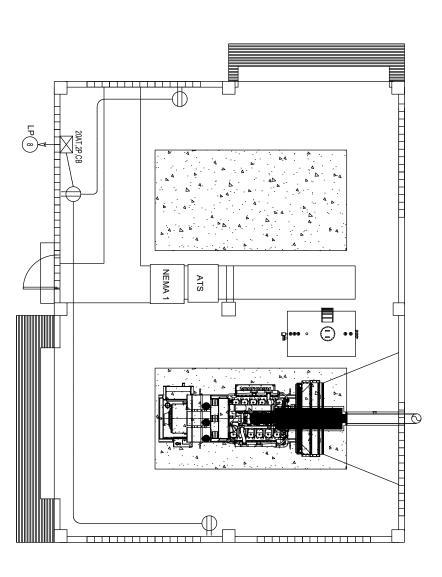


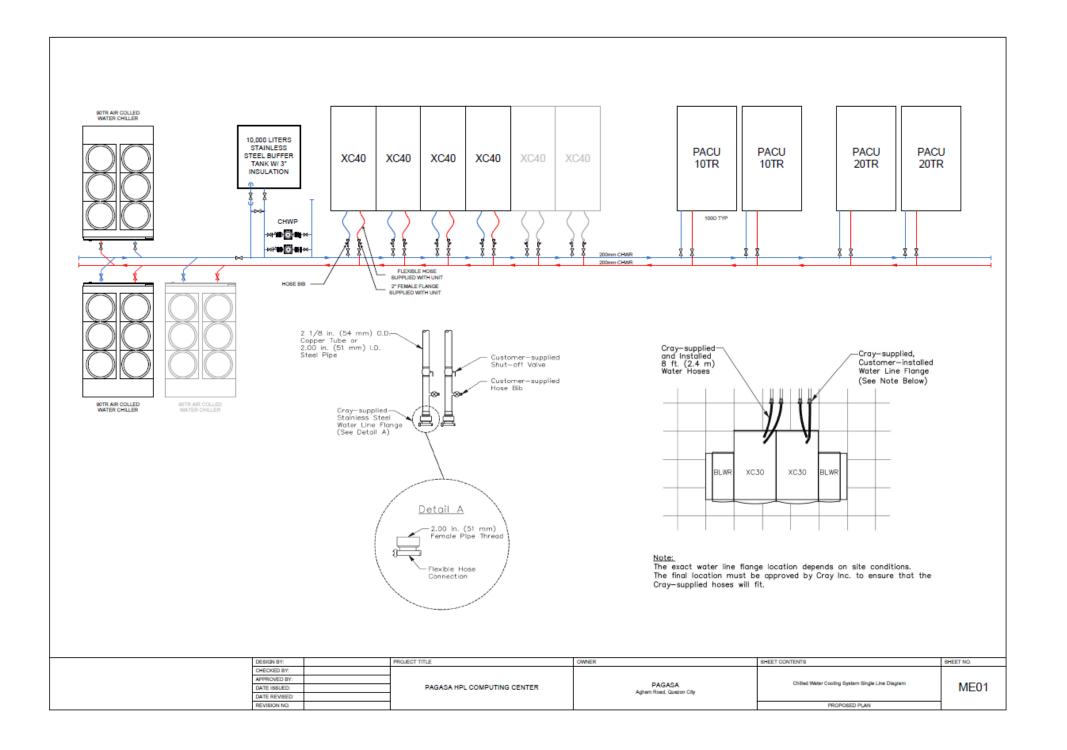

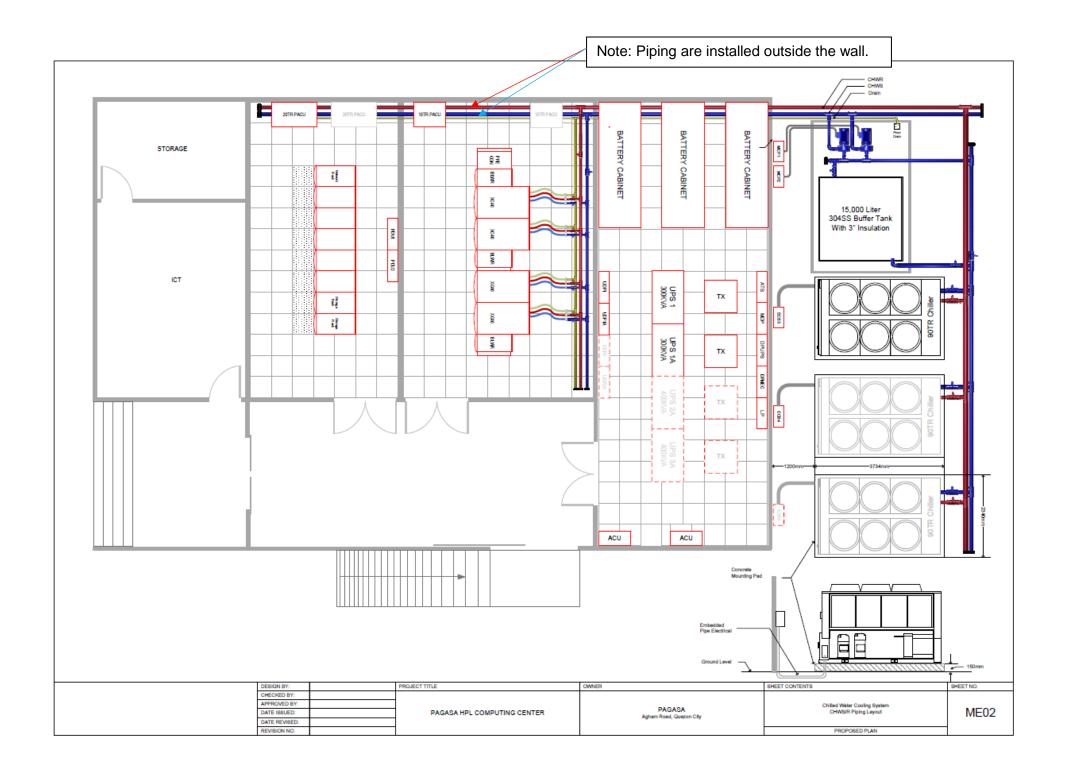

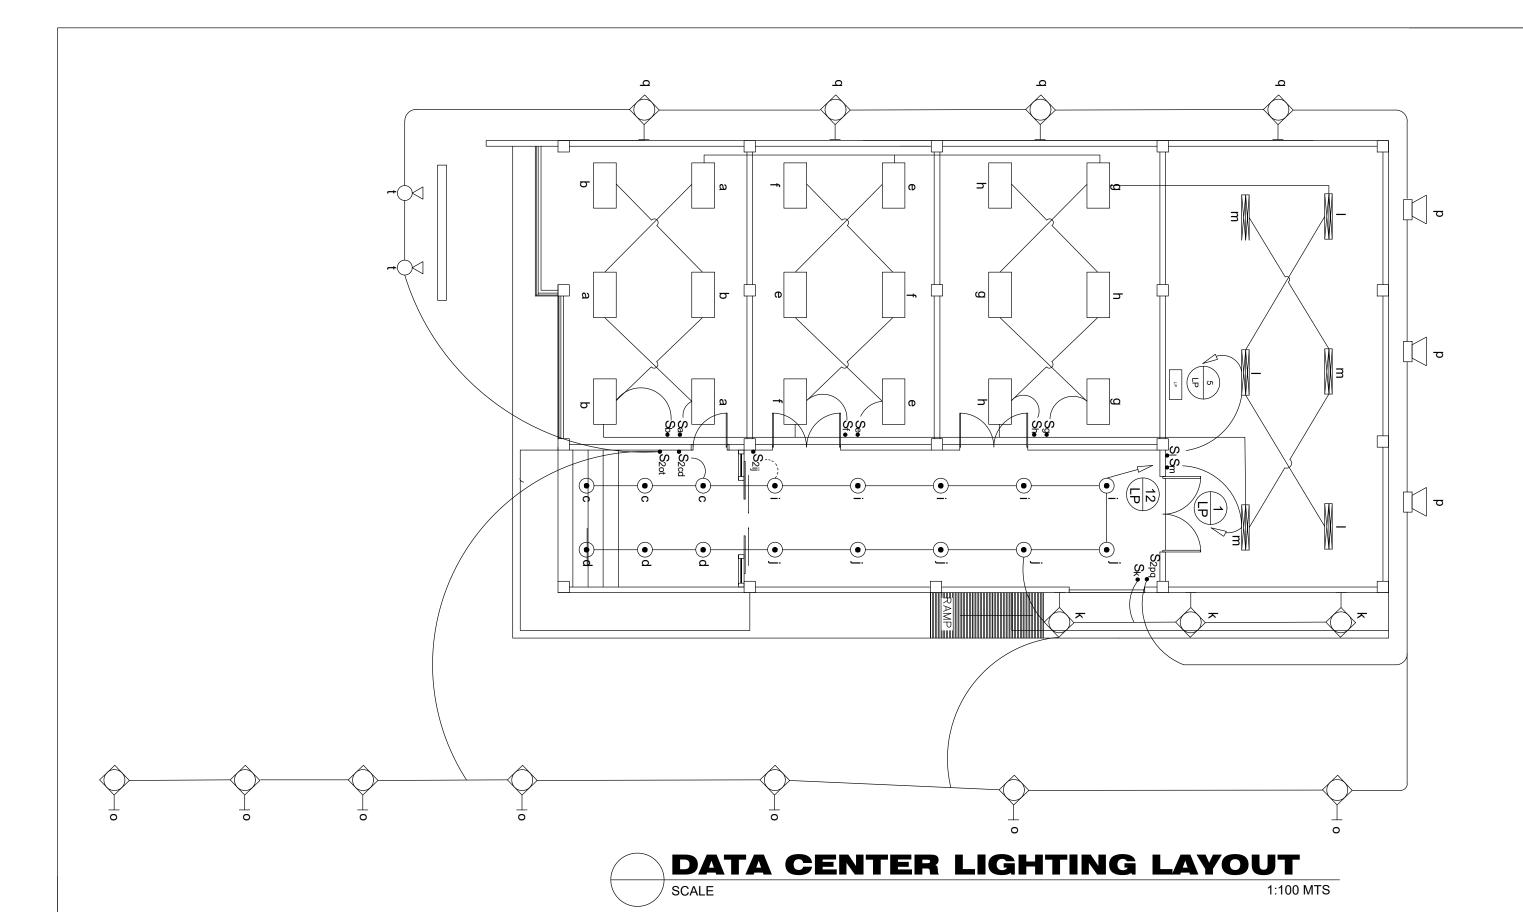

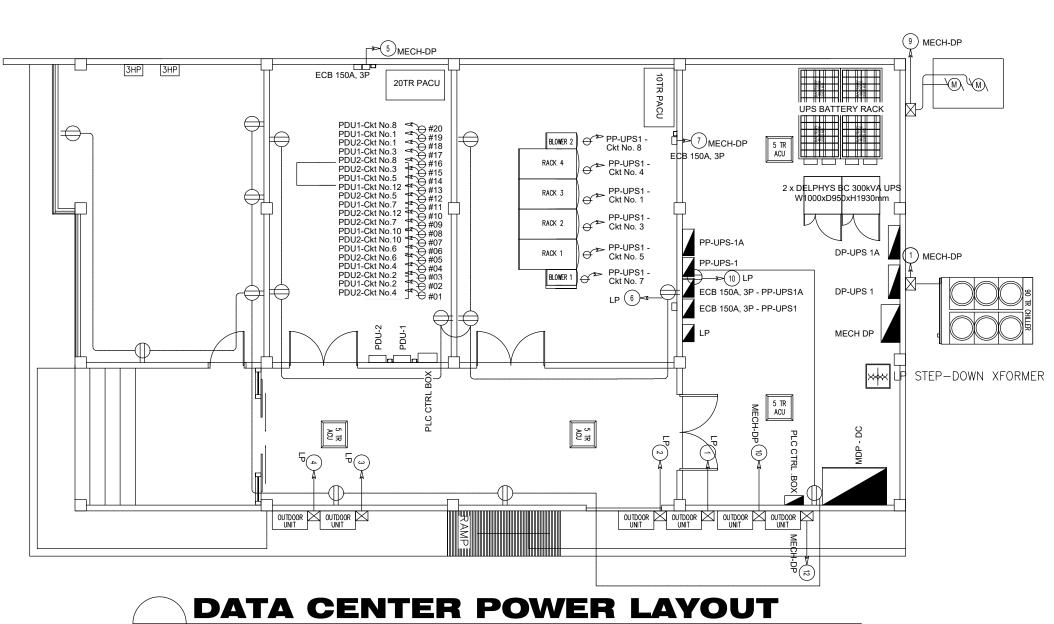POWER HOUSE LIGHTING LAYOUT
SCALE 1:100 MTS

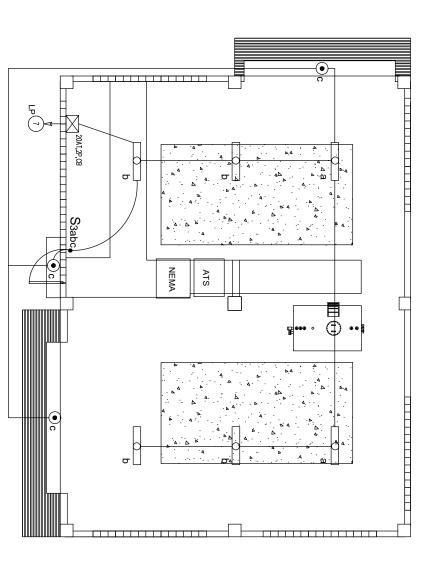



OWNER	PREPARED BY:	PROFESSIONAL ELECTRICAL ENGINEER		NGINEER	PROJECT TITLE	SHEET CONTENT	DRAWN BY :	REVISION		SHEET NO.
	EASTASIA SOLUTIONS TECHNOLOGIES CORPORATION	-			EXTENSION OF CAD BUILDING	DATA CENTER AND POWER HOUSE LIGHTING LAYOUT	- CHECKED BY	DATE :		
VICENTE B. MALANO, Ph.D. ADMINISTRATOR			EXTENSION OF CAD BUILDING	DATA CENTER AND POWER HOUSE POWER LAYOUT	CHECKED BY :			E - 2		
		LICENSE NO. : -	VALID UNTIL :	-			DATE :			
		PTR NO. : -	DATE ISSUED :	-	LOCATION: SCIENCE GARDEN COMPLEX BIR ROAD, EAST TRIANGLE, DILIMAN, QUEZON CITY		-			